#### IMPORTANT NOTES MASONRY CONTROL/ARTICULATION JOINTS - PROVIDE

- CONTROL/ARTICULATION JOINTS TO MASONRY AREAS WHERE CRACKING UNDER MOVEMENT CAN OCCUR IN ACCORDANCE WITH
- AS 3700 MASONRY STRUCTURES. STEEL WORKS - ALL FABRICATION AND INSTALLATION OF STEEL BEAMS, POSTS AND FIXINGS TO BE IN ACCORDANCE WITH AS 4100 - STEEL STRUCTURES.
- ALL MECHANICAL EXTRACTION FANS INSTALLED THROUGHOUT THE BUILDING MUST BE EXTERNALLY VENTED AND SEALED. SMOKE DETECTOR INSTALLATION MUST COMPLY WITH AS/NZS
- 3000 ELECTRICAL INSTALLATIONS AND AS 3786 SMOKE ALARMS. LICENSED ELECTRICIAN TO CONFIRM LOCATIONS.
- CONNECT Ø90mm UPVC STORM WATER LINE INTO STORM WATER TIF EXACT LOCATION OF STORM WATER TIE IS TO BE CONFIRMED BY BUILDER OR PRINCIPAL CONTRACTOR PRIOR TO CONSTRUCTION.
- NEW SEWER CONNECTION TIE-IN IS TO CONFORM TO ALL LOCAL AUTHORITY REQUIREMENTS AND MUST BE CONFIRMED BY BUILDER OR PRINCIPAL CONTRACTOR PRIOR TO CONSTRUCTION.
- NEW ELECTRICAL SERVICES CONNECTIONS ARE TO BE IN ACCORDANCE WITH ALL UTILITY AND LOCAL AUTHORITY REQUIREMENTS AND MUST BE CONFIRMED BY BUILDER OR
- PRINCIPAL CONTRACTOR PRIOR TO CONSTRUCTION. LOT BOUNDARIES AND CONTOURS MUST BE VERIFIED AND CONFIRMED ON SITE PRIOR TO CONSTRUCTION.
- FOR DETAILED INFORMATION ON RAIN WATER CONNECTIONS AND SYSTEMS, SEWER/SEPTIC CONNECTIONS AND SYSTEMS AND DRAINAGE, REFER TO HYDRAULIC ENGINEERING DRAWINGS. FOR DETAILED INFORMATION ON CONCRETE FOOTINGS, PADS,
- BEAMS AND LINTELS, ROOF STRUCTURE AND SLAB LAYOUT, REFER TO STRUCTURAL ENGINEERING DRAWINGS. TERMITE MANAGEMENT - PROVIDE PHYSICAL AND/OR CHEMICAL
- TERMITE BARRIERS TO BUILDING PERIMETER, MASONRY PIERS AND ANY PENETRATIONS IN ACCORDANCE WITH AS 3660 -TERMITE MANAGEMENT.

### ENVIRONMENTAL NOTES

- **ENVIRONMENT THIS DEVELOPMENT WILL COMPLY WITH THE** PROTECTION OF THE ENVIRONMENT OPERATIONS ACT 1997 AND THE CONSTRUCTION AND DEMOLITION WASTE TOOLKIT 2020. BIODIVERSITY AND THE LOCAL ENVIRONMENT - SITE,
- CONSTRUCTION AND LANDSCAPING WORKS WILL COMPLY WITH THE WOODBURY RIDGE ESTATE ARCHITECTURAL AND LANDSCAPE GUIDELINES AND THE WOODBURY RIDGE ESTATE BIODIVERSITY MANAGEMENT PLAN.

#### GENERAL NOTES

- WINDOWS ALL WINDOWS ARE SET AT 300mm HEAD HEIGHT UNLESS NOTED OTHERWISE ON THESE DRAWINGS.
- DOORS ALL DOORS ARE SET AT 300mm HEAD HEIGHT UNLESS
- NOTED OTHERWISE ON THESE DRAWINGS. WC SPECIFIC (x 2) - PROVIDE ARTIFICIAL LIGHT AND VENTILATION TO THE AREAS. INSTALL LIFT-OFF HINGES TO DOORS.

# OR AND WINDOW SPECIFICATIONS

FOR ALL EXTERNAL WINDOW AND DOOR SPECIFICATIONS. PLEASE REFER TO DRAWING A.012 - WINDOW + DOOR SCHEDULE

# OVIDE INSULATION (BUILDING)

		LDING/
	ROOF LEVEL -	R 1.8 75mm BUILDING BLANKET
	CEILING LEVEL -	R 5.0 GLASSWOOL BATTS
	WALLS (PRIMARY) -	R 2.5 GLASSWOOL BATTS
	WALLS (EXTERNAL) -	R 1.0 VAPOUR PERMEABLE WALL WRAP TO
	. ,	

### WALL CONSTRUCTION LEGEND

BV1 BRICK VENEER - 90mm TIMBER FRAME + 50mm CAVITY + 110mm BRICK = 250mm. REFER TO INSULATION SCHEDULE FOR INSULATION SPECIFICATIONS.


FCL -EMB -


DP -

AC -FG -

EGL -NGL -

- DB1 DOUBLE BRICK (GARAGE) 110mm BRICK + 10mm MORTAR + 110mm BRICK = 230mm
- SSC1 STRATCO HILAND TRAY 265 STANDING SEAM CLADDING (PARAPET DESIGN) - 90mm TIMBER FRAME + 12mm STRUCTURAL PLYWOOD + 35mm BATTEN + 38mm METAL CLADDING = 175mm. REFER TO INSULATION SCHEDULE FOR INSULATION SPECIFICATIONS.
- SSC2 STRATCO HILAND TRAY 265 STANDING SEAM CLADDING (GABLE DESIGN) - 90mm TIMBER FRAME + 12mm PLYWOOD + 35mm BATTEN + 38mm METAL CLADDING + 75mm PACKERS = 250mm. REFER TO INSULATION SCHEDULE FOR INSULATION SPECIFICATIONS.

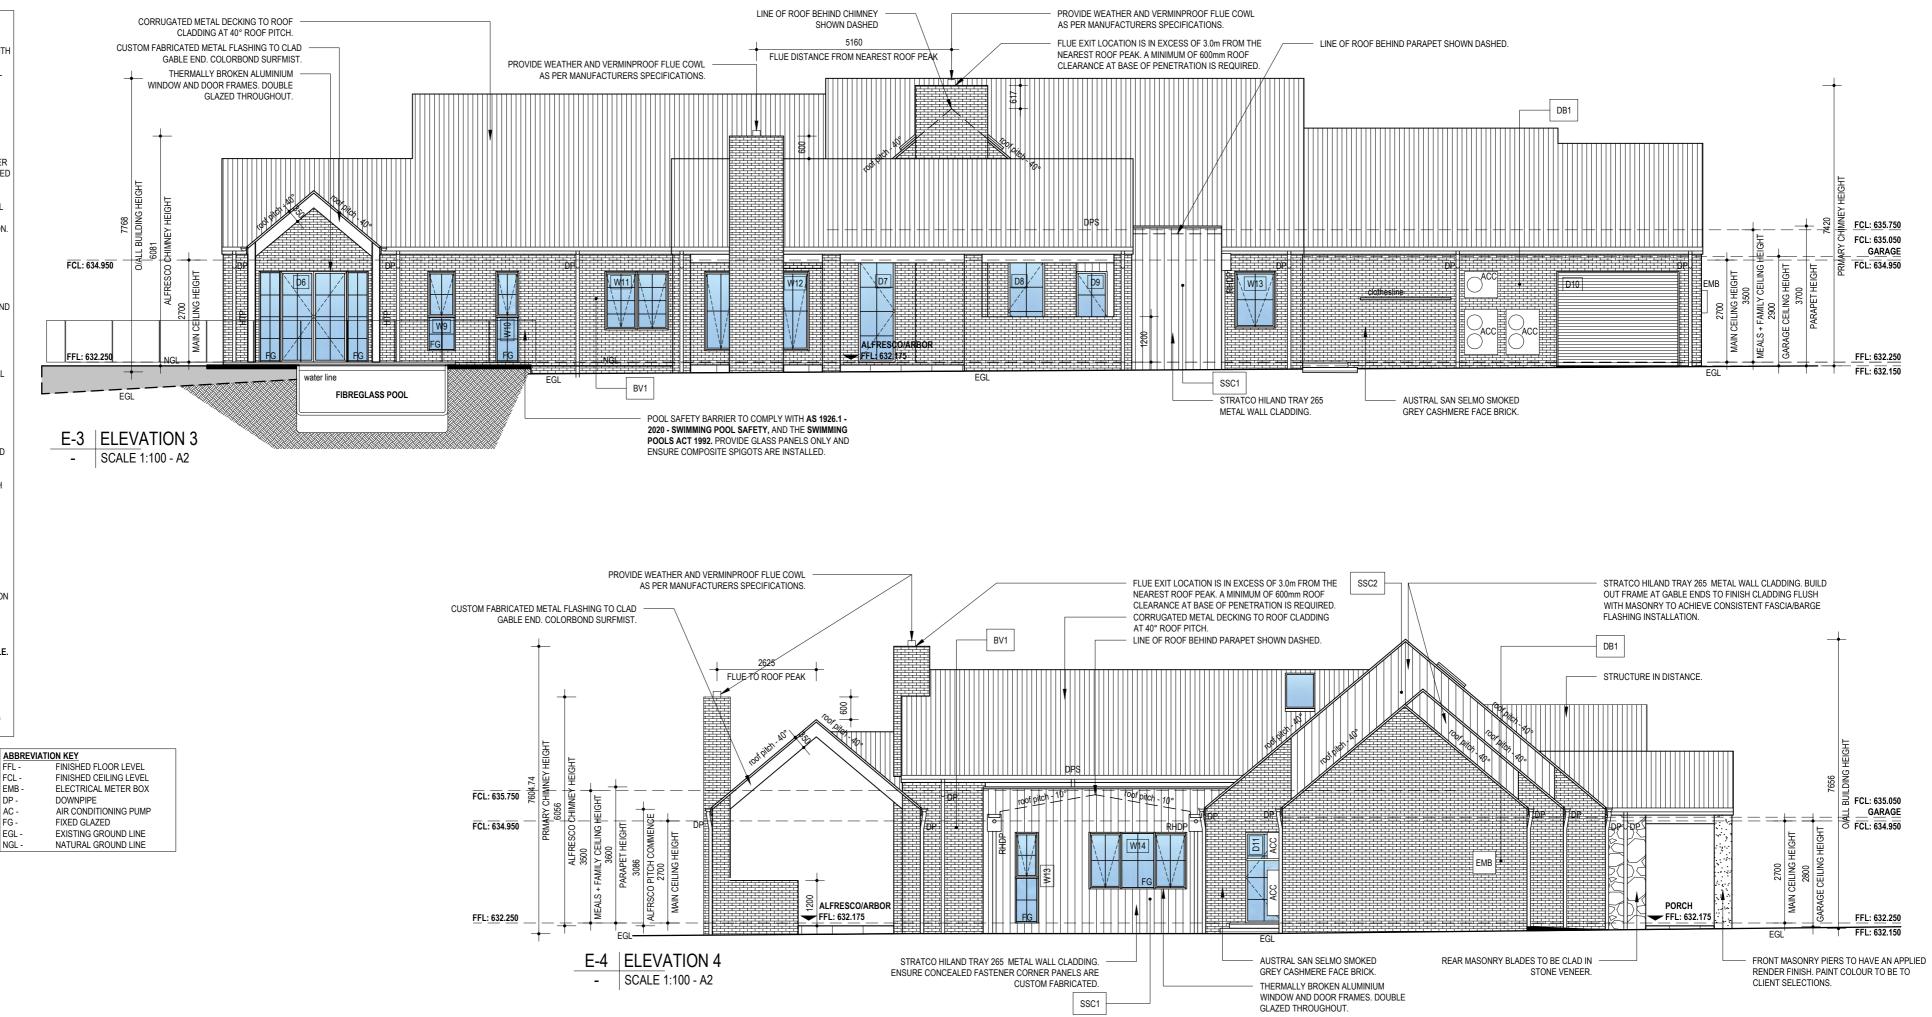

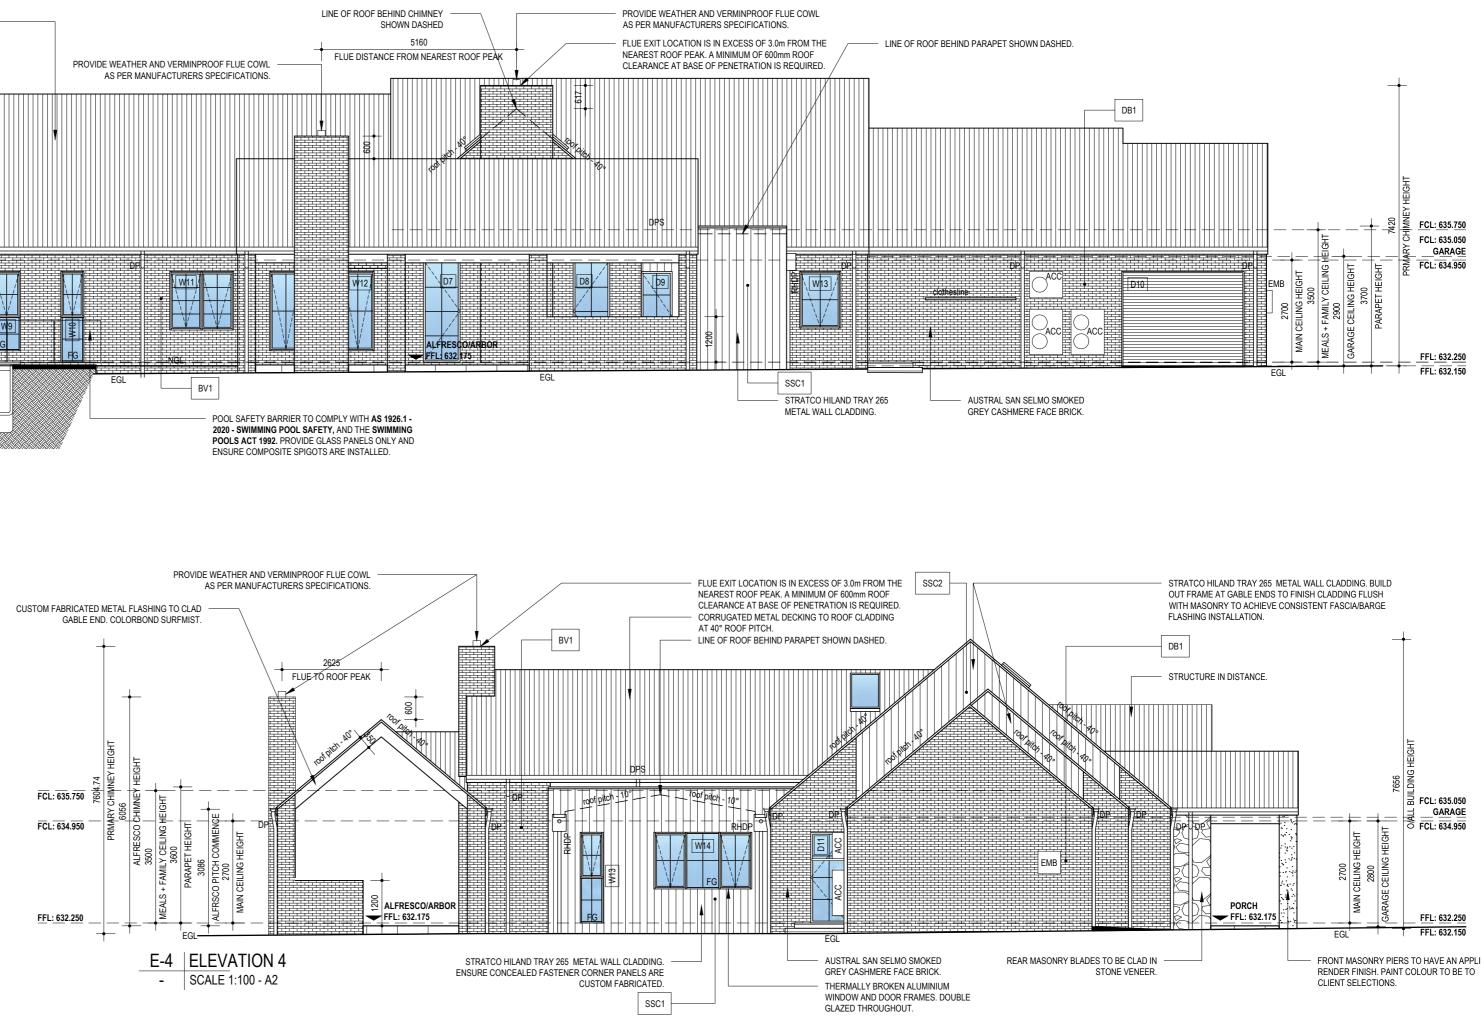



Client Name STEPHEN + AMANDA CAMPBELL Drawing Title **BUILDING ELEVATIONS 3 + 4** 

Project Description PROPOSED NEW DWELLING Project Address

LOT: 20 DP: 271494 DIV: SUTTON 52 WOODBURY DRIVE SUTTON NSW 2620

# Project Date 01 NOVEMBER 2024 Project No. SUTTON

PAUĽ DE FLUMERI Version Drawn By **2.3a** Drawn By PAUL DE FLUMERI CAMPBELL

Designed By

# Amendments

BEDROOM 5 ROOF DESIGN AMENDED 2 ALFRESCO STRUCTURE DESIGN AMENDED 3 WIP/BEDROOM 5 LAYOUT CHANGES 4 ALFRESCO + FRONT FACADE AMENDED

#### Project Stage 5 JULY 2024 5 JULY 2024 5 JULY 2024 PRELIMINARY 10 JULY 2024 COMP. DEV. CERTIFICATE

 DEVELOPMENT
APPROVAL CONSTRUCTION CERTIFICATE

Scale 1:100 - A2 TENDER Sheet No. CONSTRUCTION A.006

FOR